


ROOF SYSTEM
 1x8 T&G DECKING (APPLIED SEPARATELY)
 6 1/2" UCC STRUCTURAL INSULATED
 PANEL (R-38)
 ROOFING FELT
 ASPHALT ROOFING SHINGLES


FRAME SPECIES IS EASTERN WHITE PINE #2
 OR SELECT DOUGLAS FIR, #1 DOUGLAS FIR

WALL SYSTEM
 4 1/2" UCC STRUCTURAL INSULATED
 PANEL (R-25)
 AIR BARRIER (OPTIONAL)

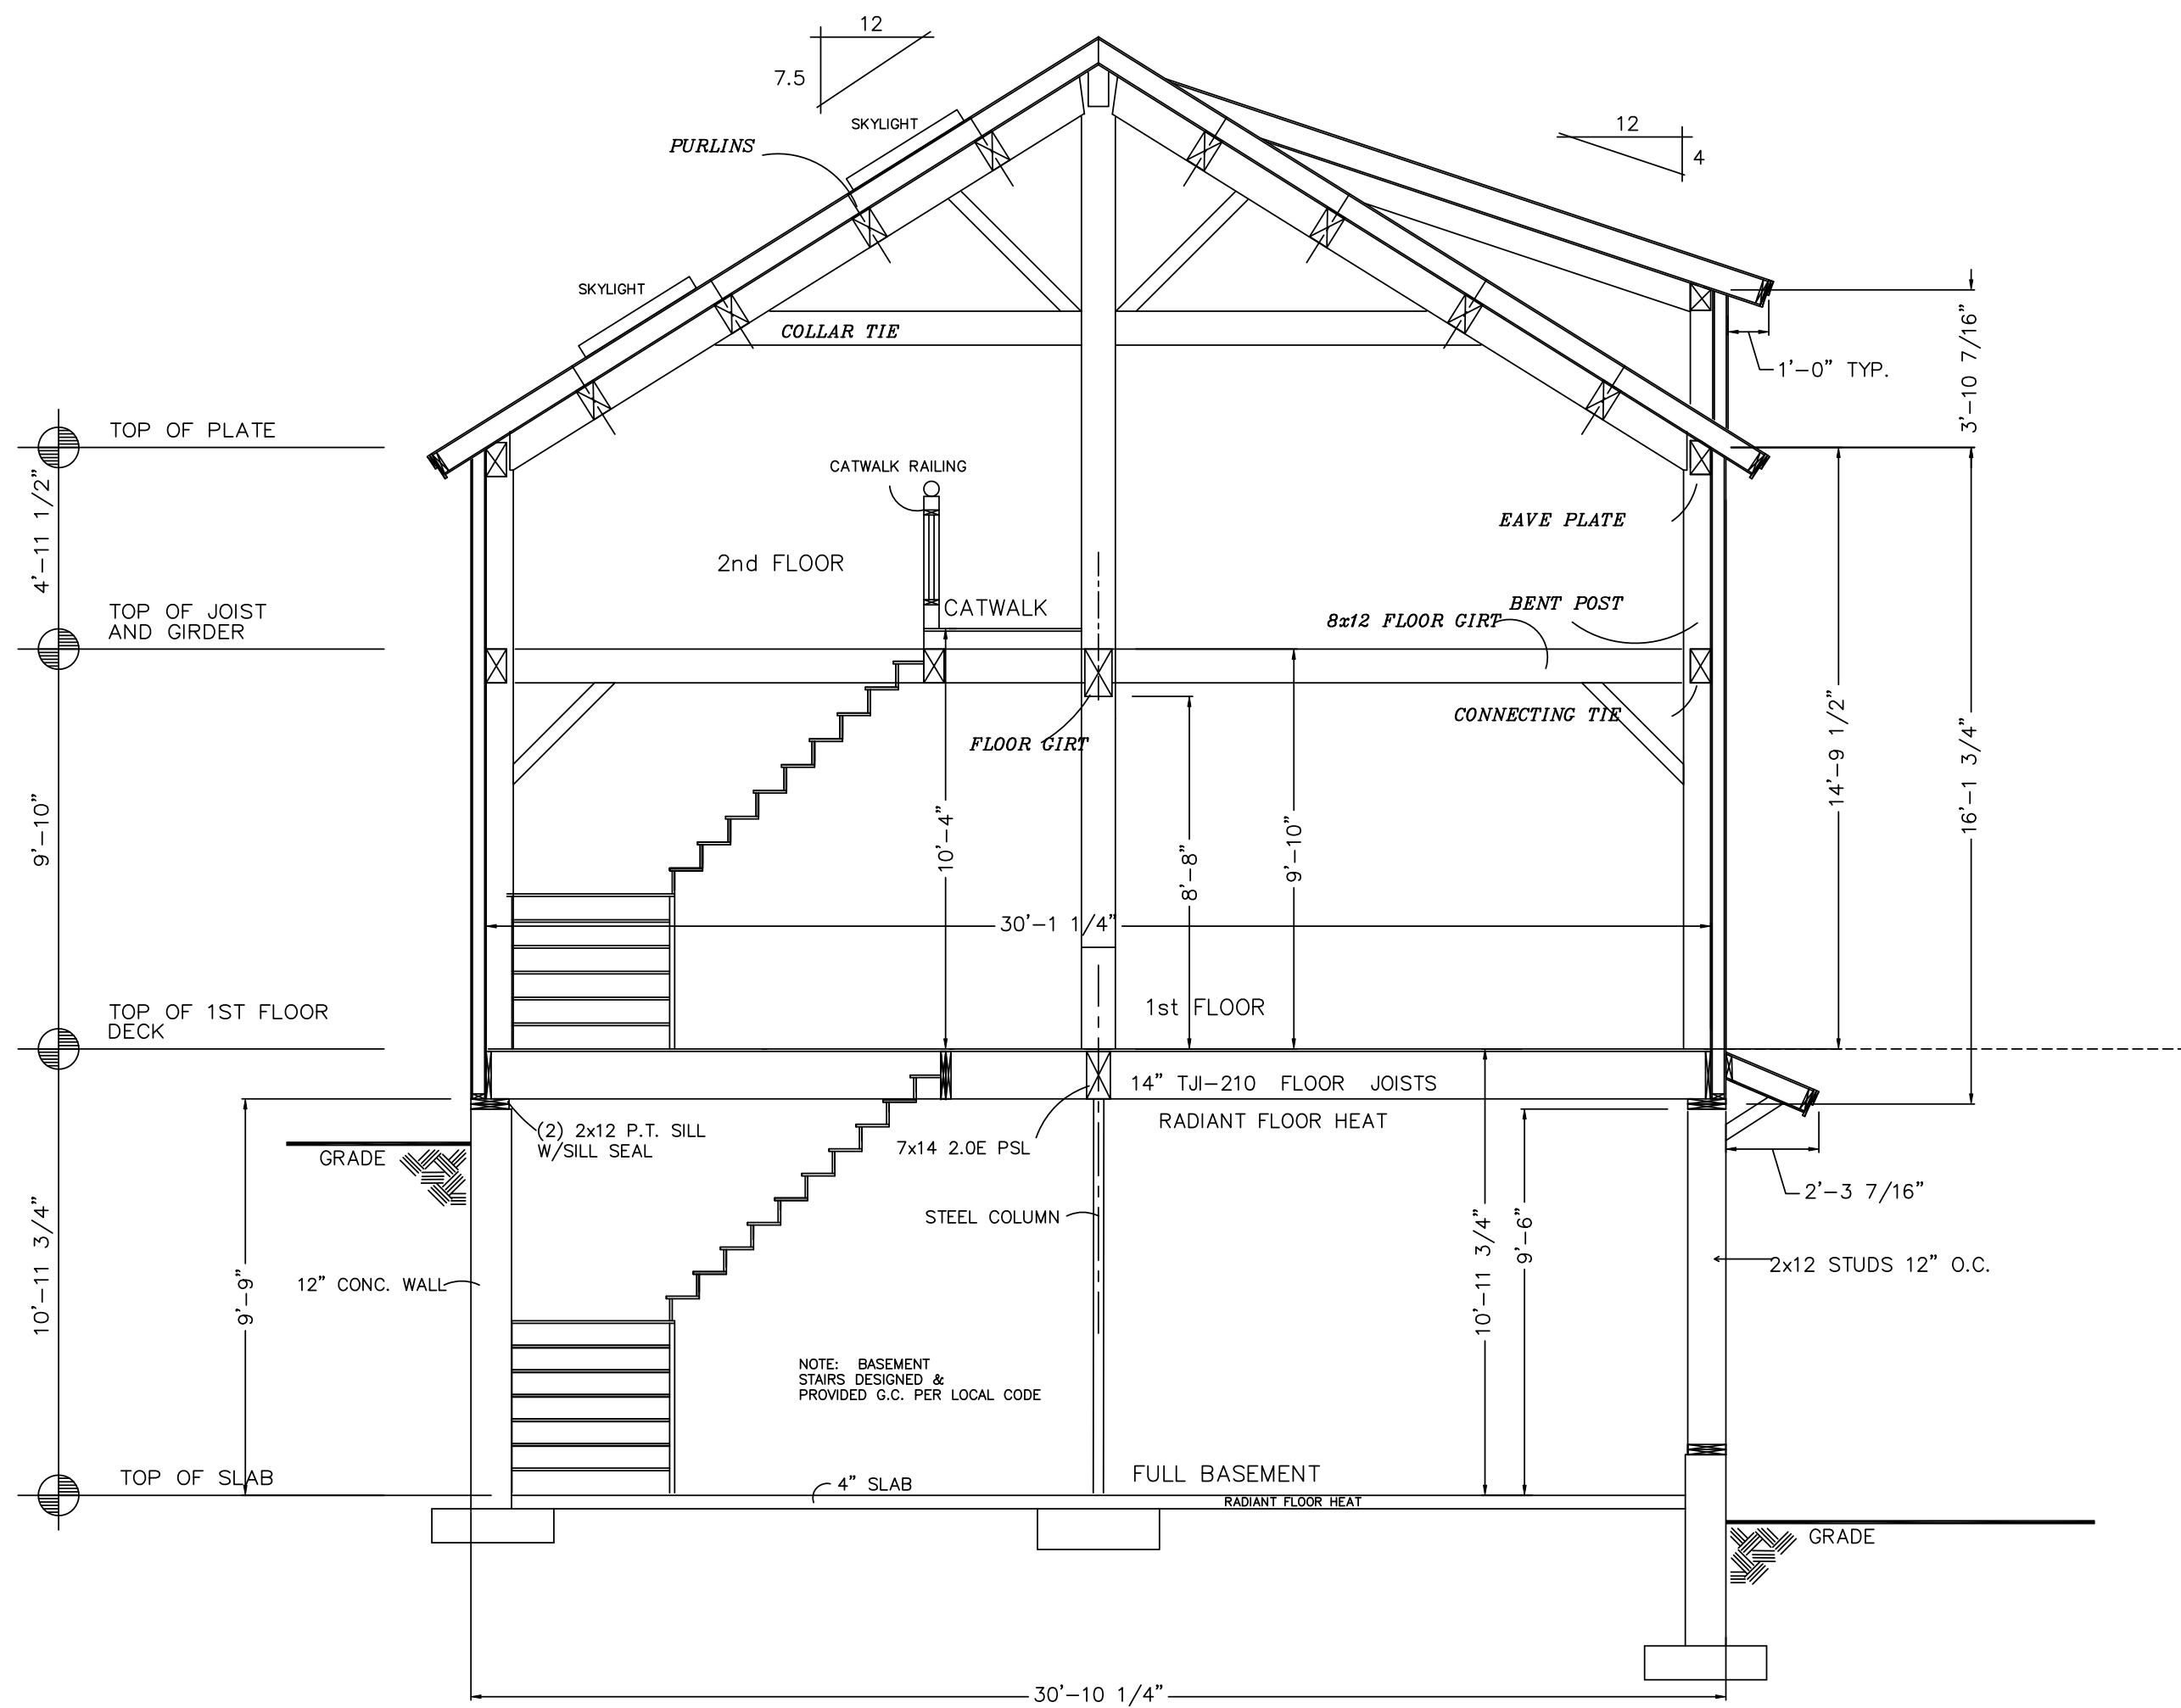


BUILDING SECTION A-A

FINAL LOCATION OF ALL INTERIOR PARTITIONS TO BE DETERMINED AT SITE.
 ALL EXTERIOR DECKS, STEPS, RAILS AND SHOULD MEET STATE AND LOCAL CODES
 LOCATION AND ENGINEERING OF ANY RETAINING WALLS IS BY OTHERS
 ANY CONSTRUCTION BY OTHERS NOTED AS TO BE VERIFIED (I.B.V.), IS TO BE VERIFIED FOR ACCURACY BY THE OWNER AND/OR BUILDER.
 THE STAIR RISER AND TREAD DIMENSIONS ARE CALCULATED FROM THE TOP OF THE 1ST FLR DECK TO THE TOP OF THE SECOND FLOOR DECK. BUILDER TO ADJUST FOR FLOOR FINISHES AS NEEDED.
 FIREPLACE AND/OR WOODSTOVE INSTALLATION IS TO COMPLY WITH ALL LOCAL, STATE AND NATIONAL FIRE SAFETY CODES AND REGULATIONS.
 ALL DOORS, WALLS AND CEILINGS BETWEEN THE GARAGE AND LIVING SPACES ARE TO MEET ALL FIRE AND SAFETY CODE REGULATIONS.

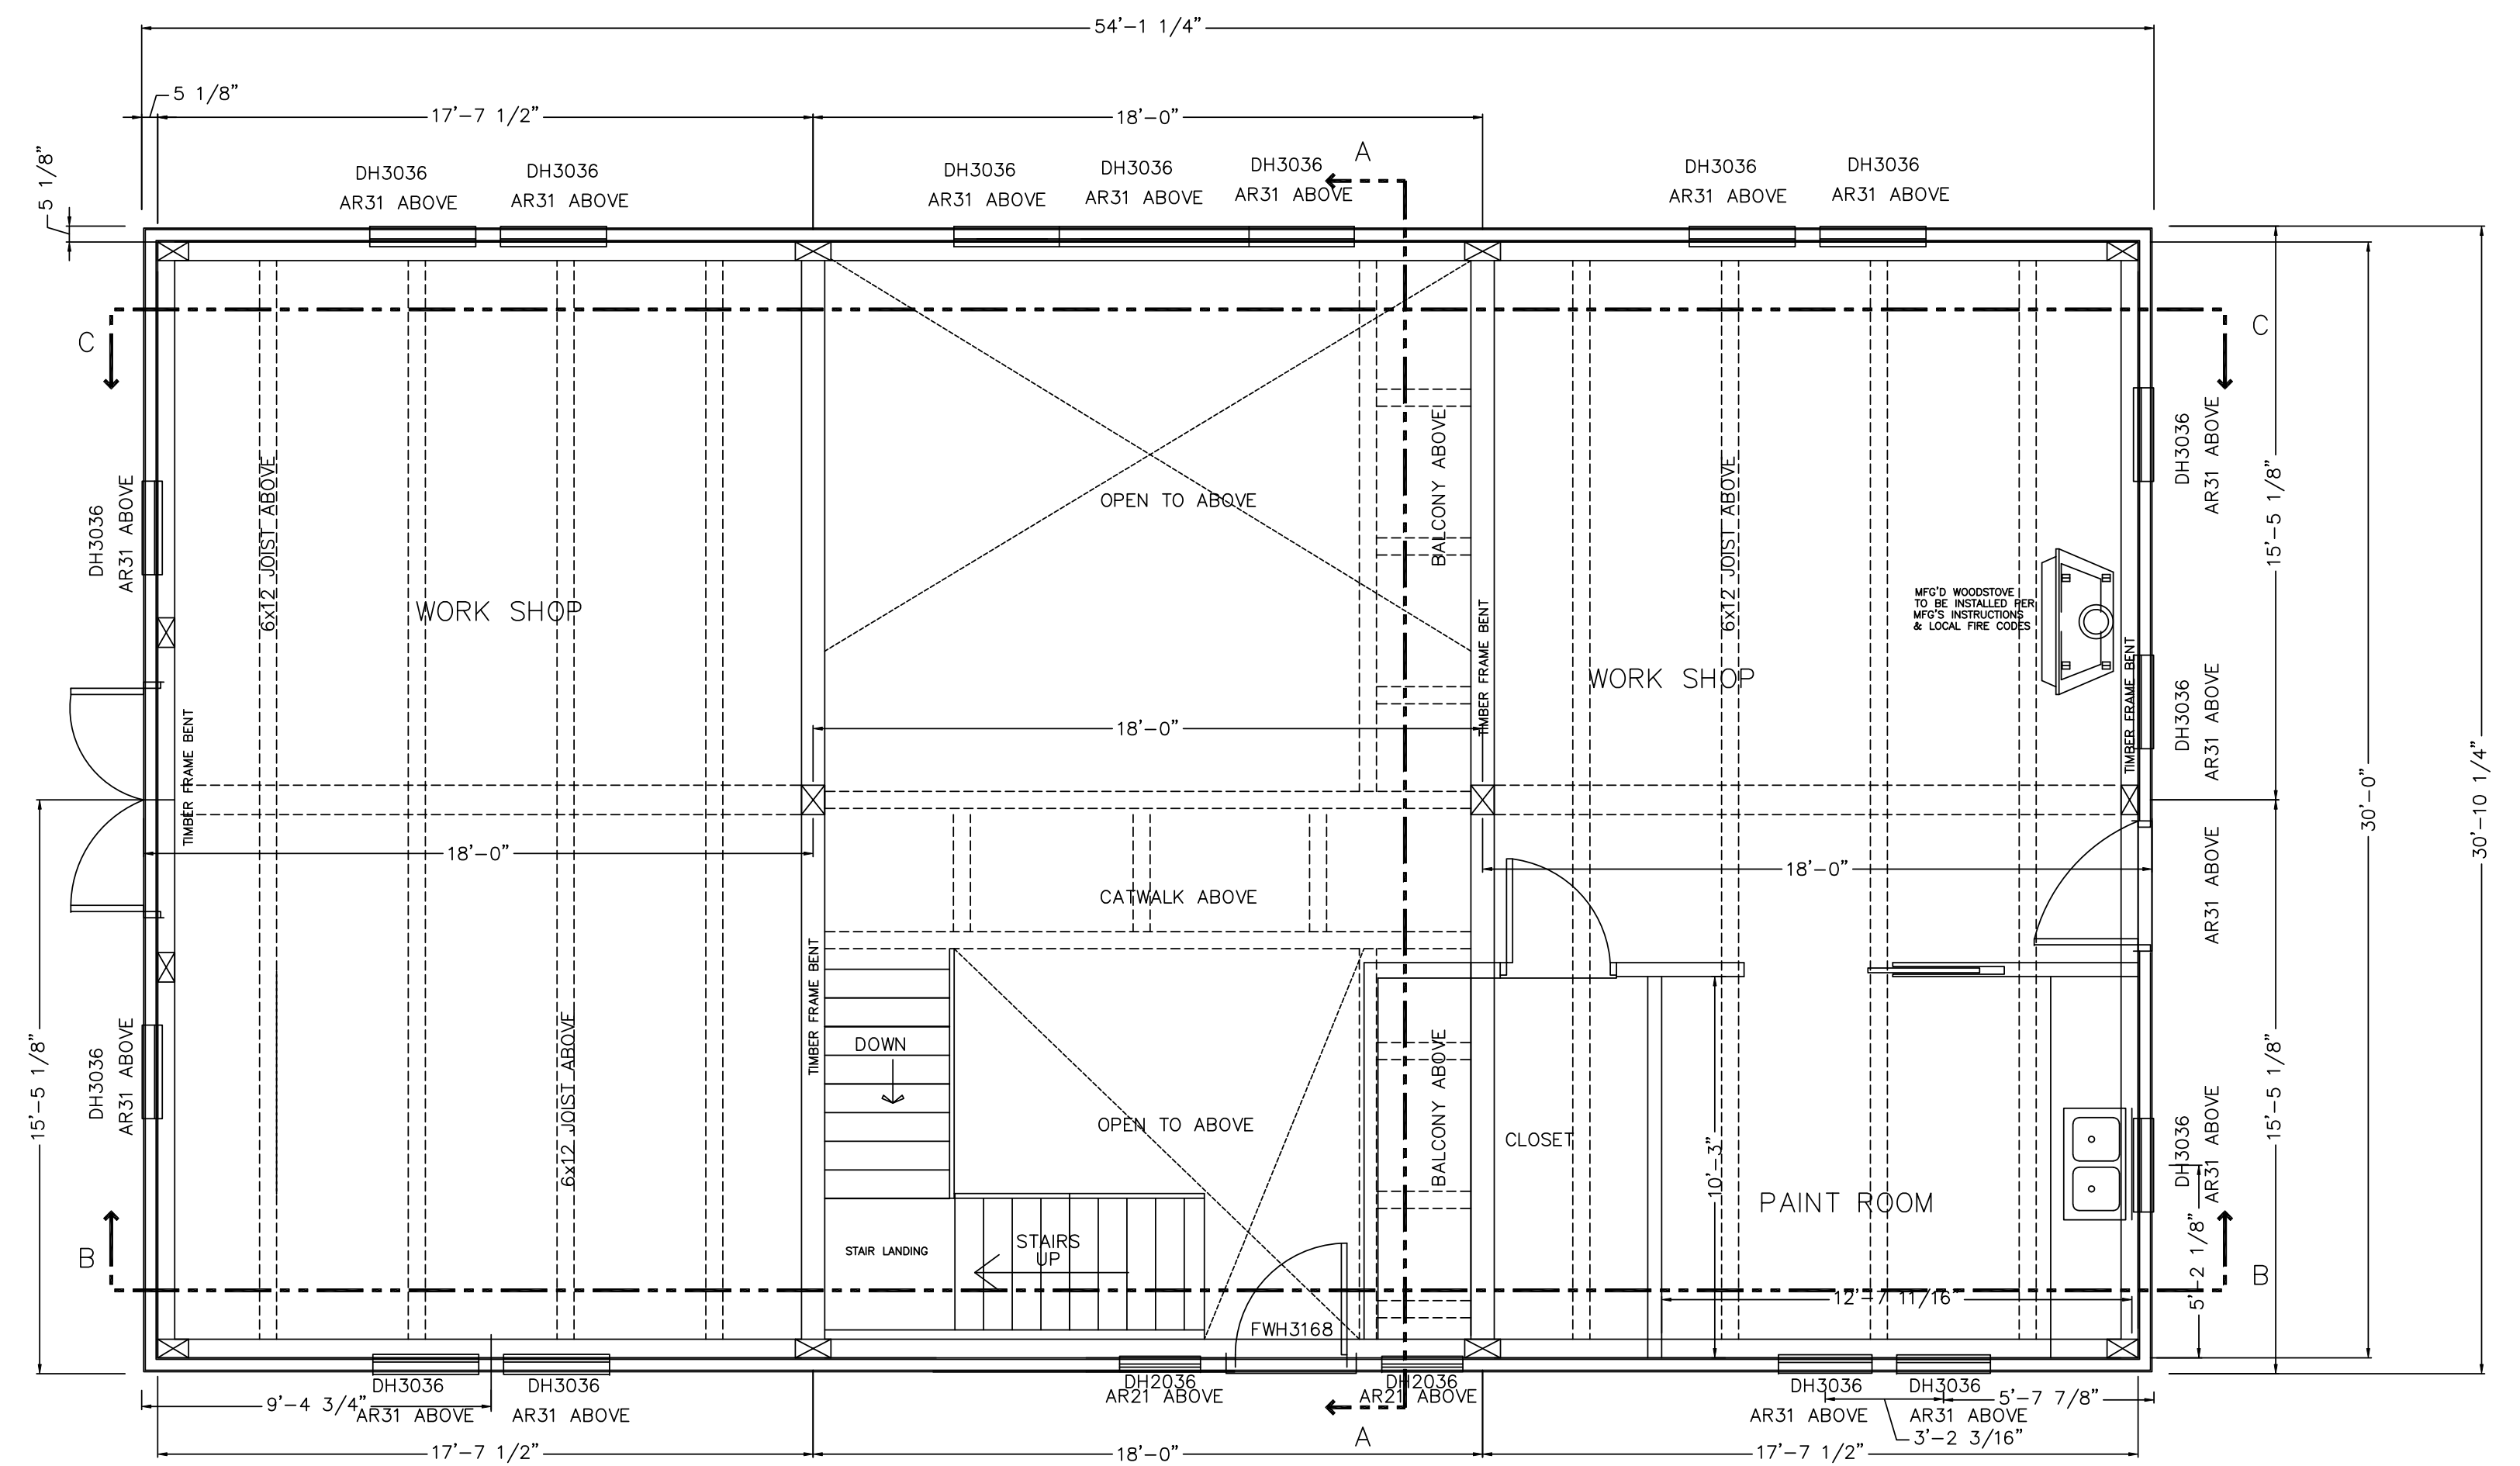

FIRST FLOOR PLAN PROJECT NORTH

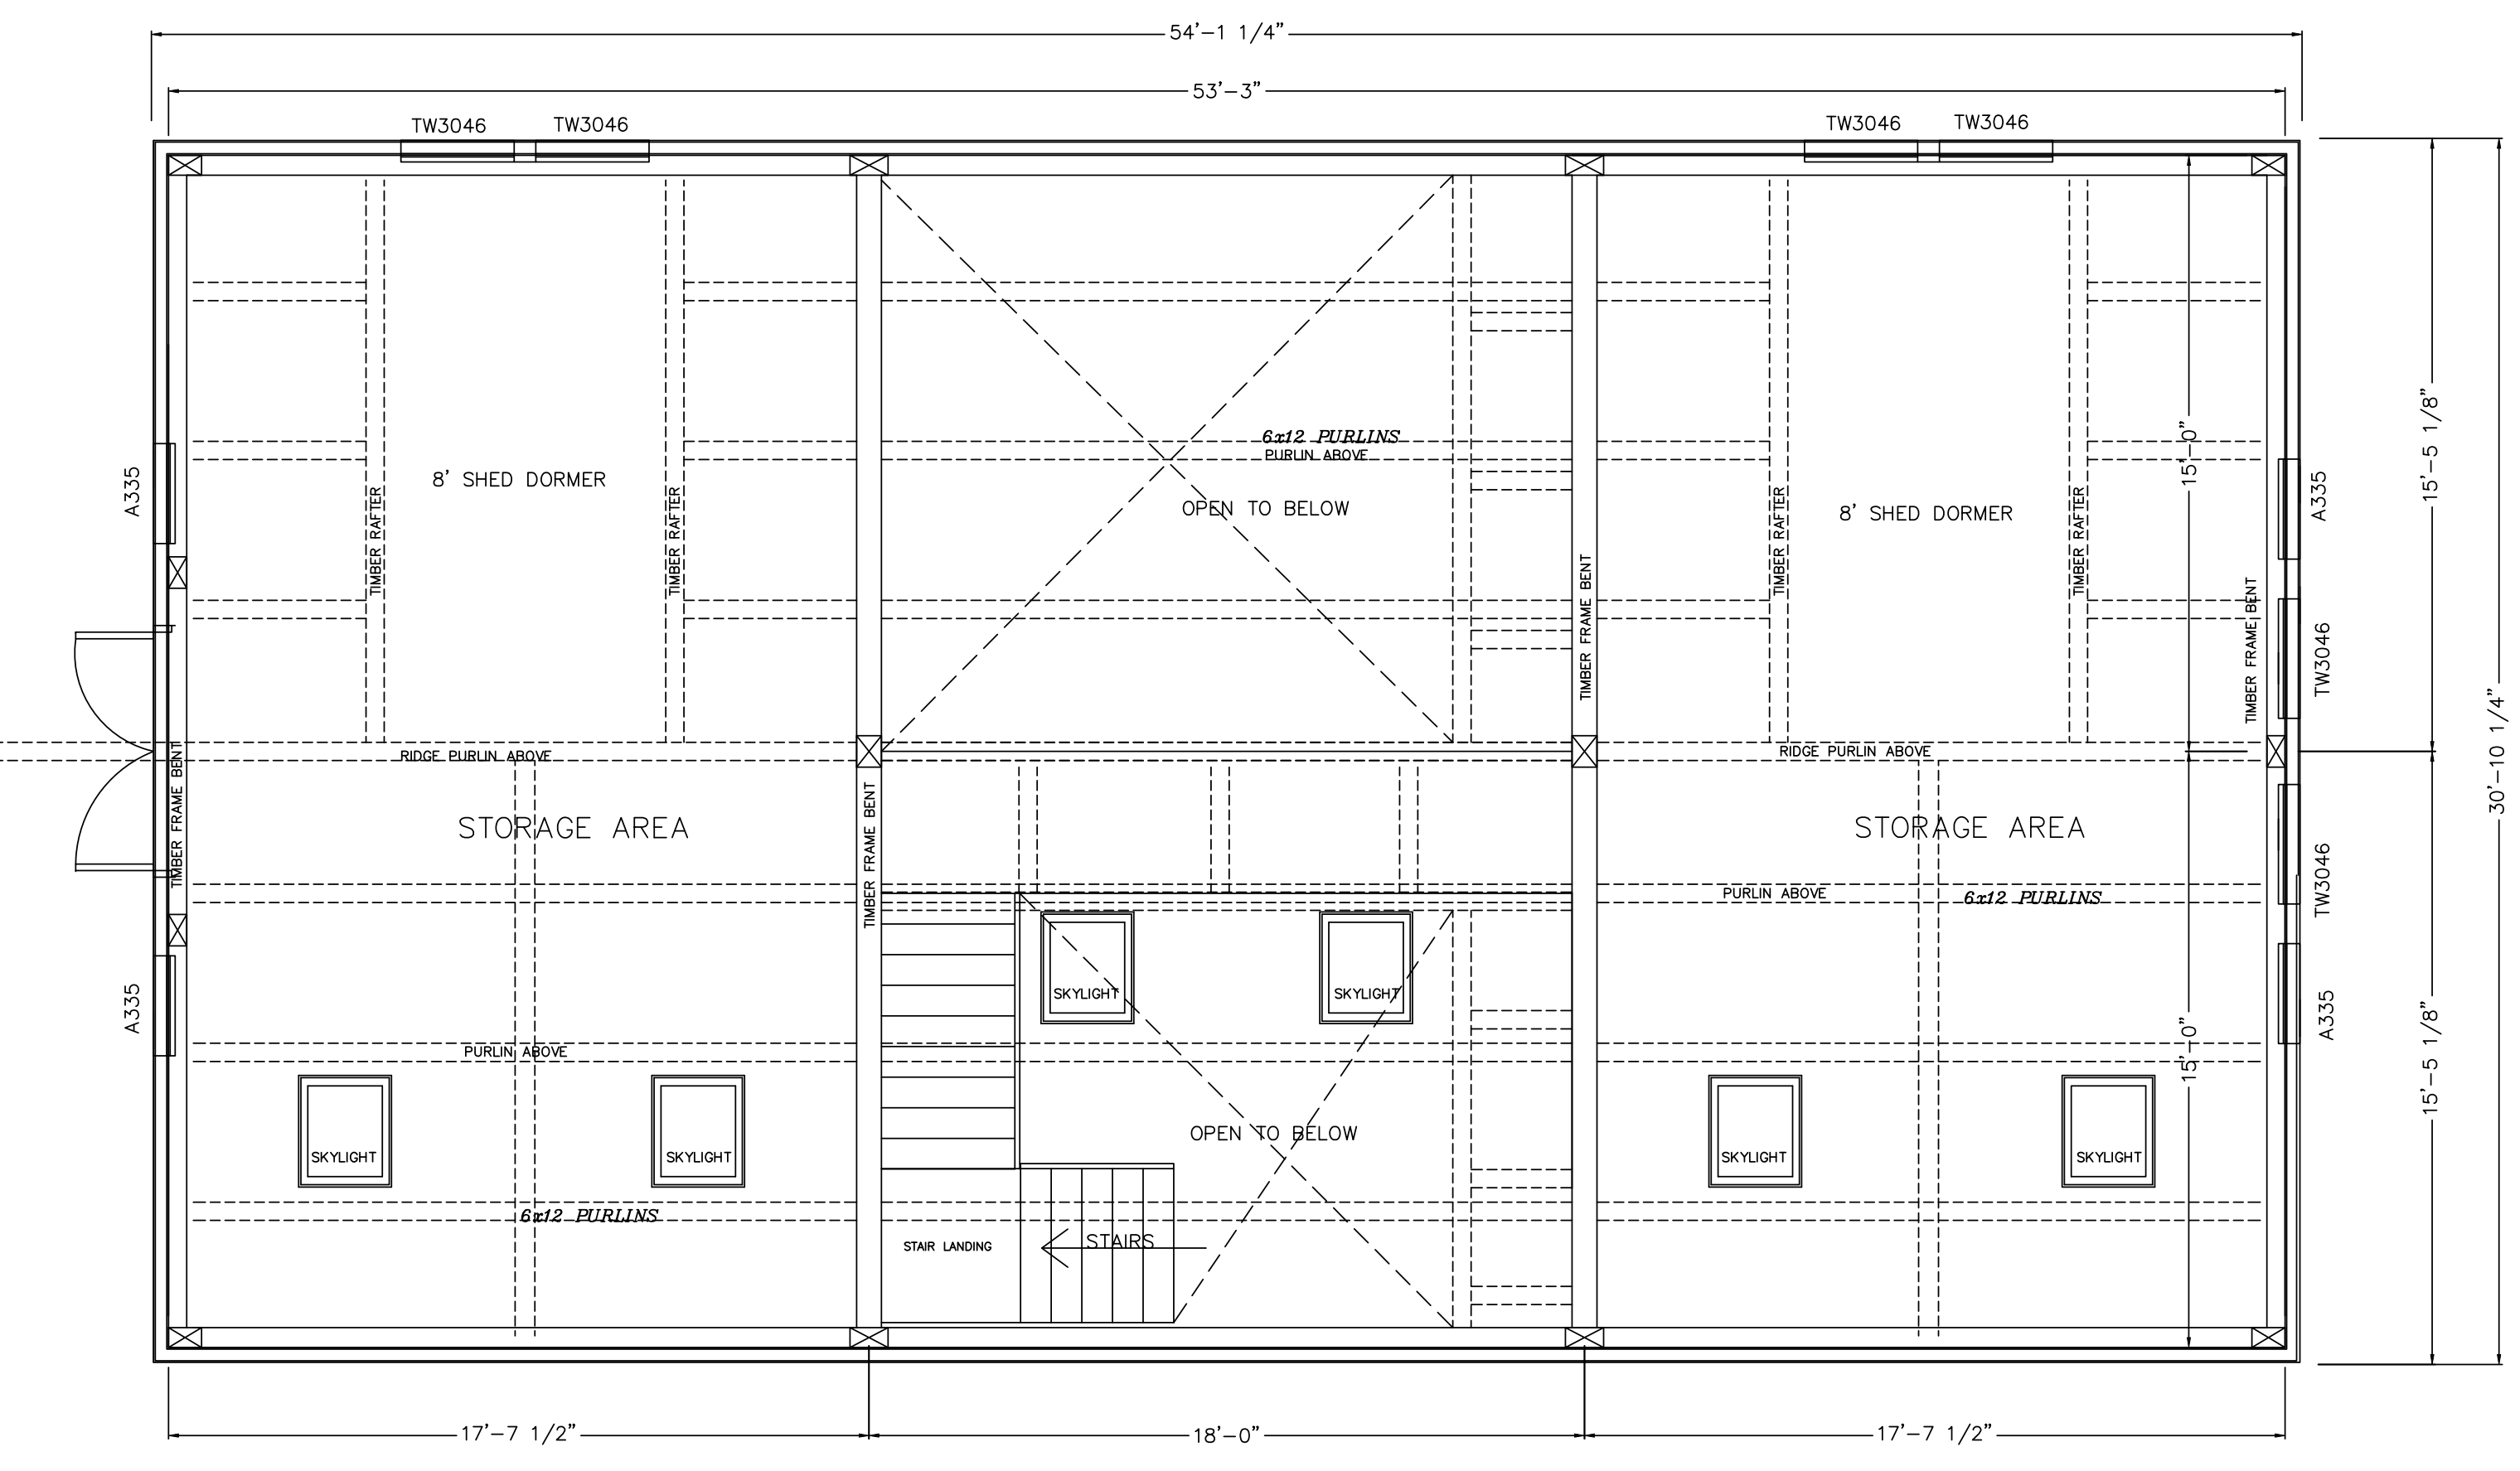

SECOND FLOOR PLAN PROJECT NORTH

REVISIONS	
DATE	NUMBER & DESCRIPTION
5/11/03	
8/3/03	
11/5/03	
11/24/03	
2/3/04	

SCALE: 1/4" = 1'-0"

DATE: DRAWN BY: DEW CHECKED BY:

JOB NAME: **BRIAN BOYLE TRURO, MA**

DW TIMBER FRAME DESIGN, LLC
 TIMBER FRAME & PANEL HOME DESIGN
 76 HOWARD STREET, KEENE, N.H. 03431
 PHONE: (603)357-9744 FAX: (603)358-6216

FINAL LOCATION OF ALL INTERIOR PARTITIONS TO BE DETERMINED AT SITE.

ALL EXTERIOR DECKS, STEPS, RAILS AND SHOULD MEET STATE AND LOCAL CODES


LOCATION AND ENGINEERING OF ANY RETAINING WALLS IS BY OTHERS

ANY CONSTRUCTION BY OTHERS NOTED AS TO BE VERIFIED (T.B.V.), IS TO BE VERIFIED FOR ACCURACY BY THE OWNER AND/OR BUILDER.

THE STAIR RISER AND TREAD DIMENSIONS ARE CALCULATED FROM THE TOP OF THE 1ST FLR DECK TO THE TOP OF THE SECOND FLOOR DECK. BUILDER TO ADJUST FOR FLOOR FINISHES AS NEEDED.

FIREPLACE AND/OR WOODSTOVE INSTALLATION IS TO COMPLY WITH ALL LOCAL, STATE AND NATIONAL FIRE SAFETY CODES AND REGULATIONS.

ALL DOORS, WALLS AND CEILINGS BETWEEN THE GARAGE AND LIVING SPACES ARE TO MEET ALL FIRE AND SAFETY CODE REGULATIONS.

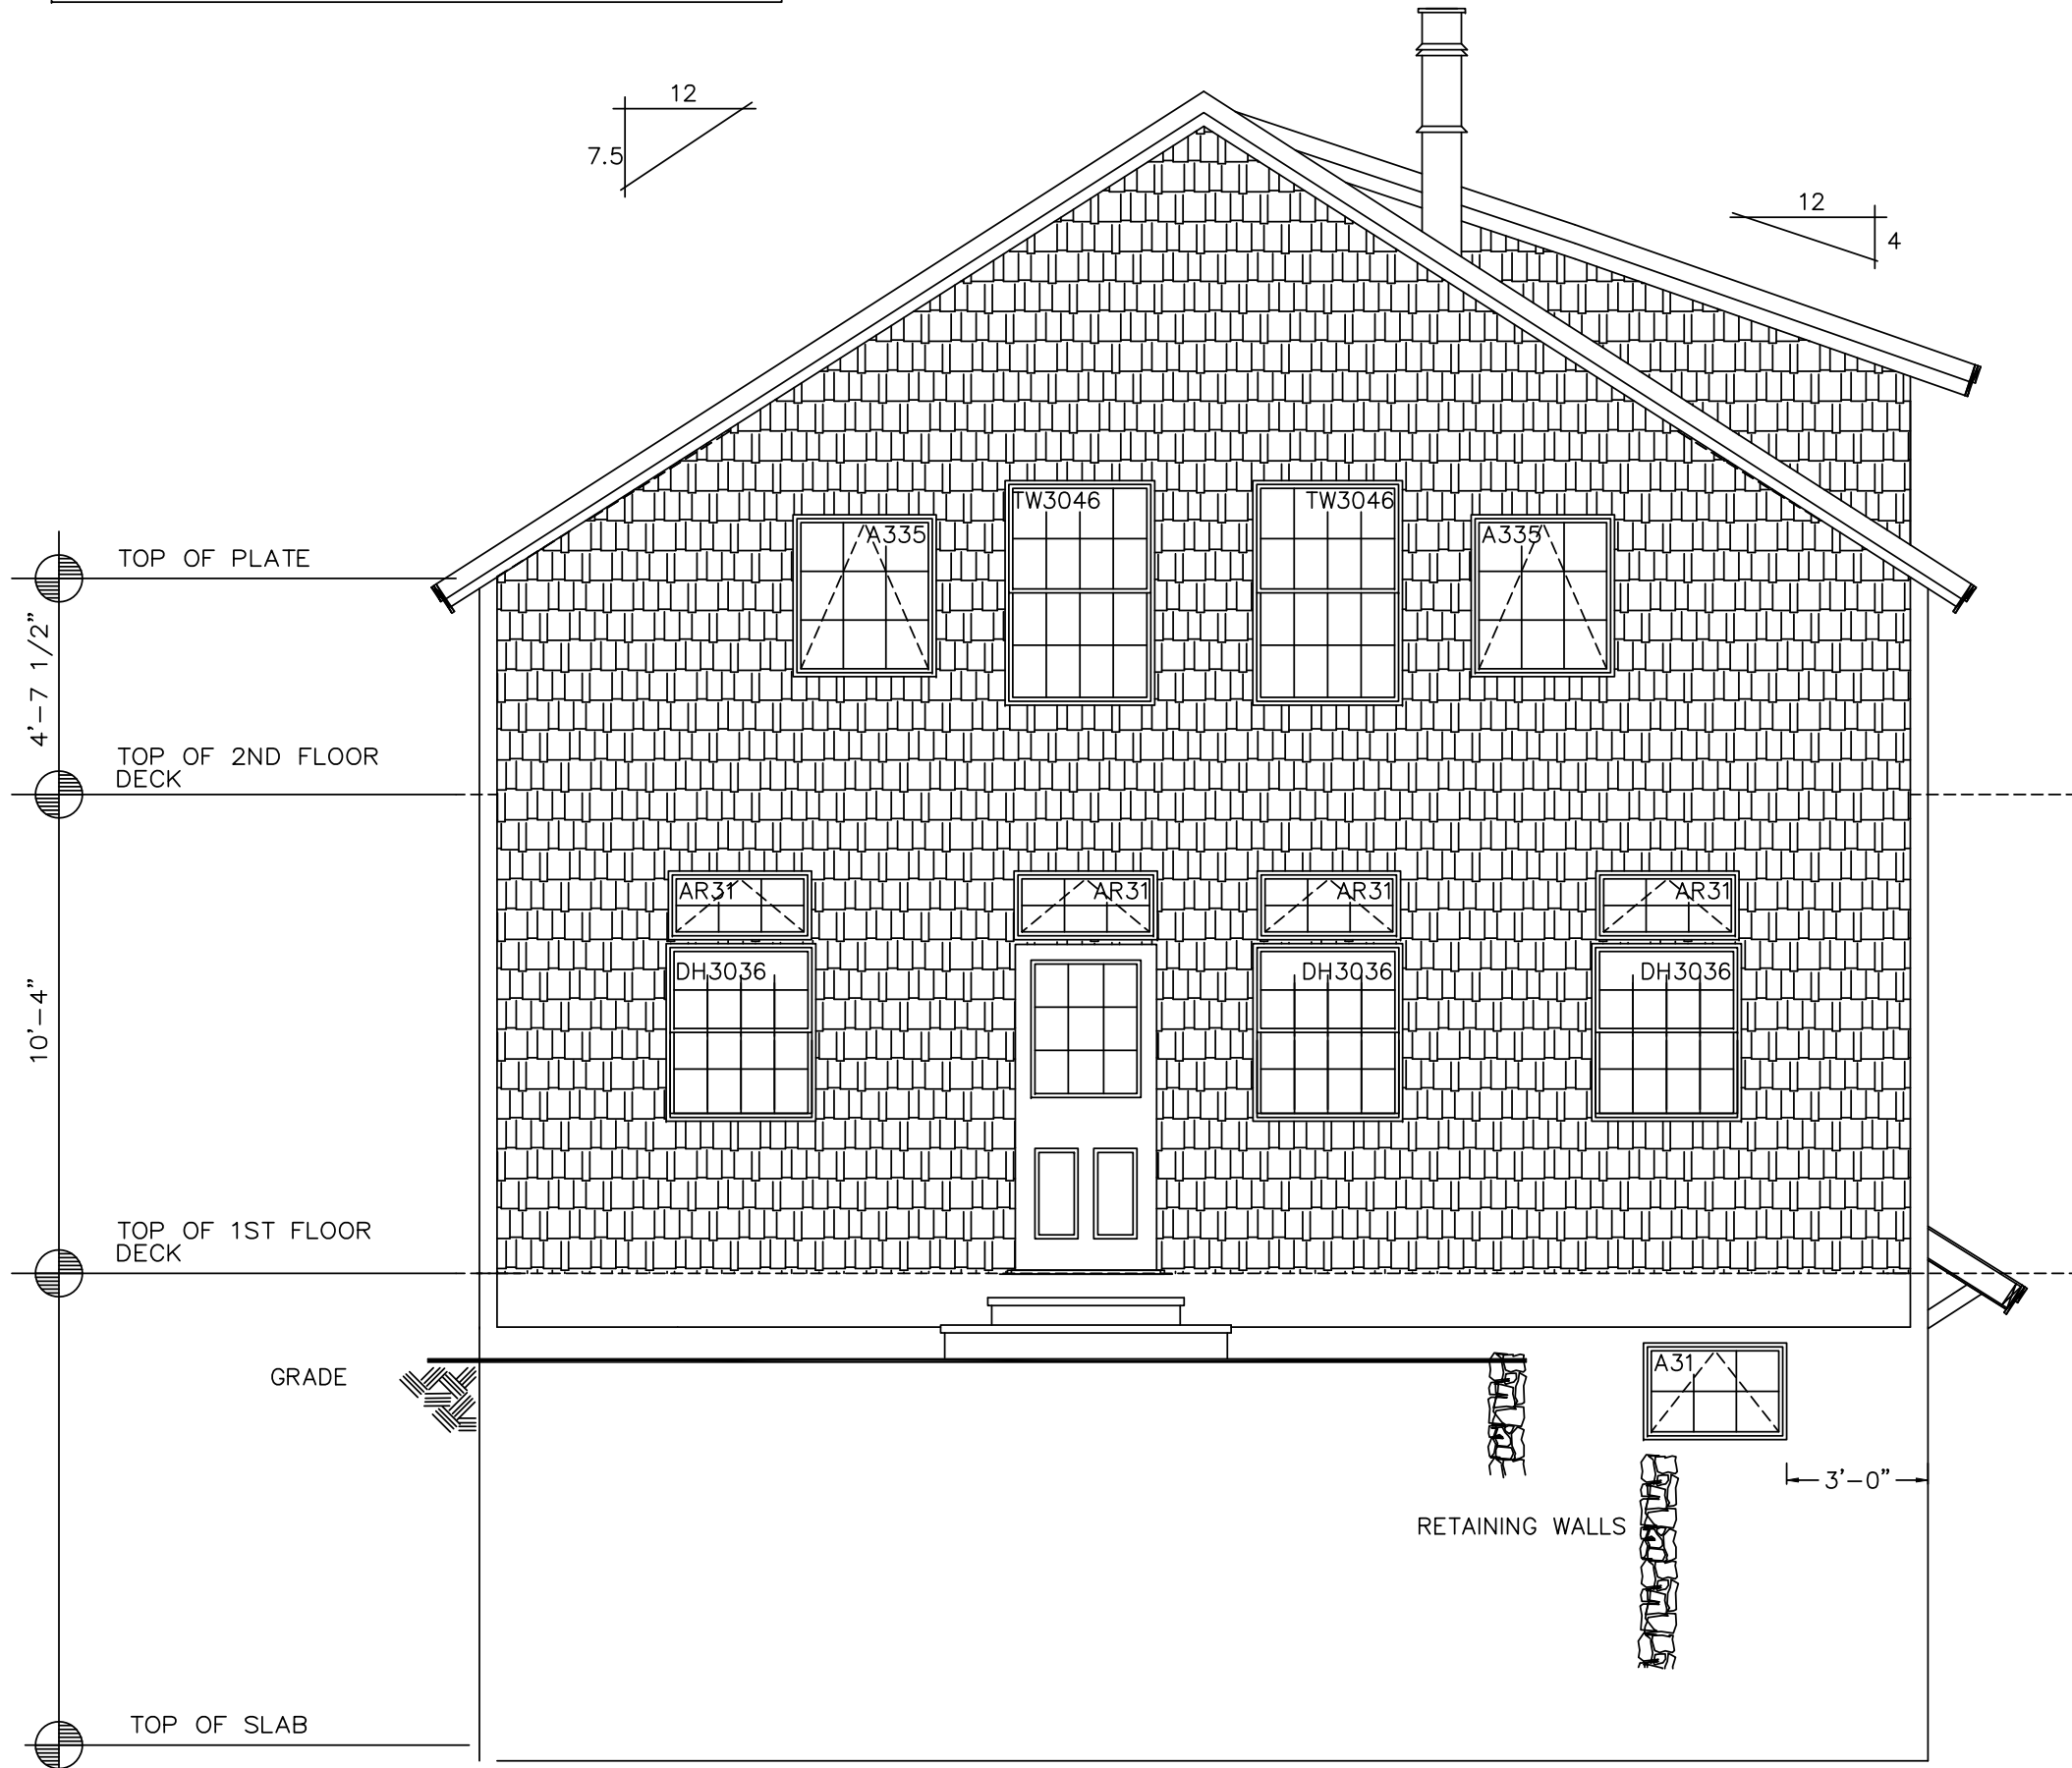

SOUTH ELEVATION



EAST ELEVATION

FRAME SPECIES IS EASTERN WHITE PINE #2 OR SELECT DOUGLAS FIR, #1 DOUGLAS FIR

ROOF: IS 6 1/2" STRUCTURAL INSULATED (UCC) PANELS. THEY SHALL BE APPLIED TO TIMBER FRAME OVER 3/4" T & G BOARDS.

WALLS: ARE 4 1/2" STRUCTURAL INSULATED (UCC) PANELS. THEY SHALL BE APPLIED TO TIMBER FRAME OVER 1/2" SHEETROCK.

REVISIONS	
DATE:	NUMBER & DESCRIPTION
5/11/03	
8/3/03	
11/5/03	
11/24/03	
2/3/04	

SCALE: 1/4" = 1'-0"

DATE: _____

DRAWN BY: **DEW**

CHECKED BY: _____

JOB NAME: **BRIAN BOYLE TRURO, MA**

DW TIMBER FRAME DESIGN, LLC
TIMBER FRAME & PANEL HOME DESIGN
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FINAL LOCATION OF ALL INTERIOR PARTITIONS TO BE DETERMINED AT SITE.

ALL EXTERIOR DECKS, STEPS, RAILS AND SHOULD MEET STATE AND LOCAL CODES


LOCATION AND ENGINEERING OF ANY RETAINING WALLS IS BY OTHERS

ANY CONSTRUCTION BY OTHERS NOTED AS TO BE VERIFIED (T.B.V.), IS TO BE VERIFIED FOR ACCURACY BY THE OWNER AND/OR BUILDER.


THE STAIR RISER AND TREAD DIMENSIONS ARE CALCULATED FROM THE TOP OF THE 1ST FLR DECK TO THE TOP OF THE SECOND FLOOR DECK. BUILDER TO ADJUST FOR FLOOR FINISHES AS NEEDED.

FIREPLACE AND/OR WOODSTOVE INSTALLATION IS TO COMPLY WITH ALL LOCAL, STATE AND NATIONAL FIRE SAFETY CODES AND REGULATIONS.

ALL DOORS, WALLS AND CEILINGS BETWEEN THE GARAGE AND LIVING SPACES ARE TO MEET ALL FIRE AND SAFETY CODE REGULATIONS.

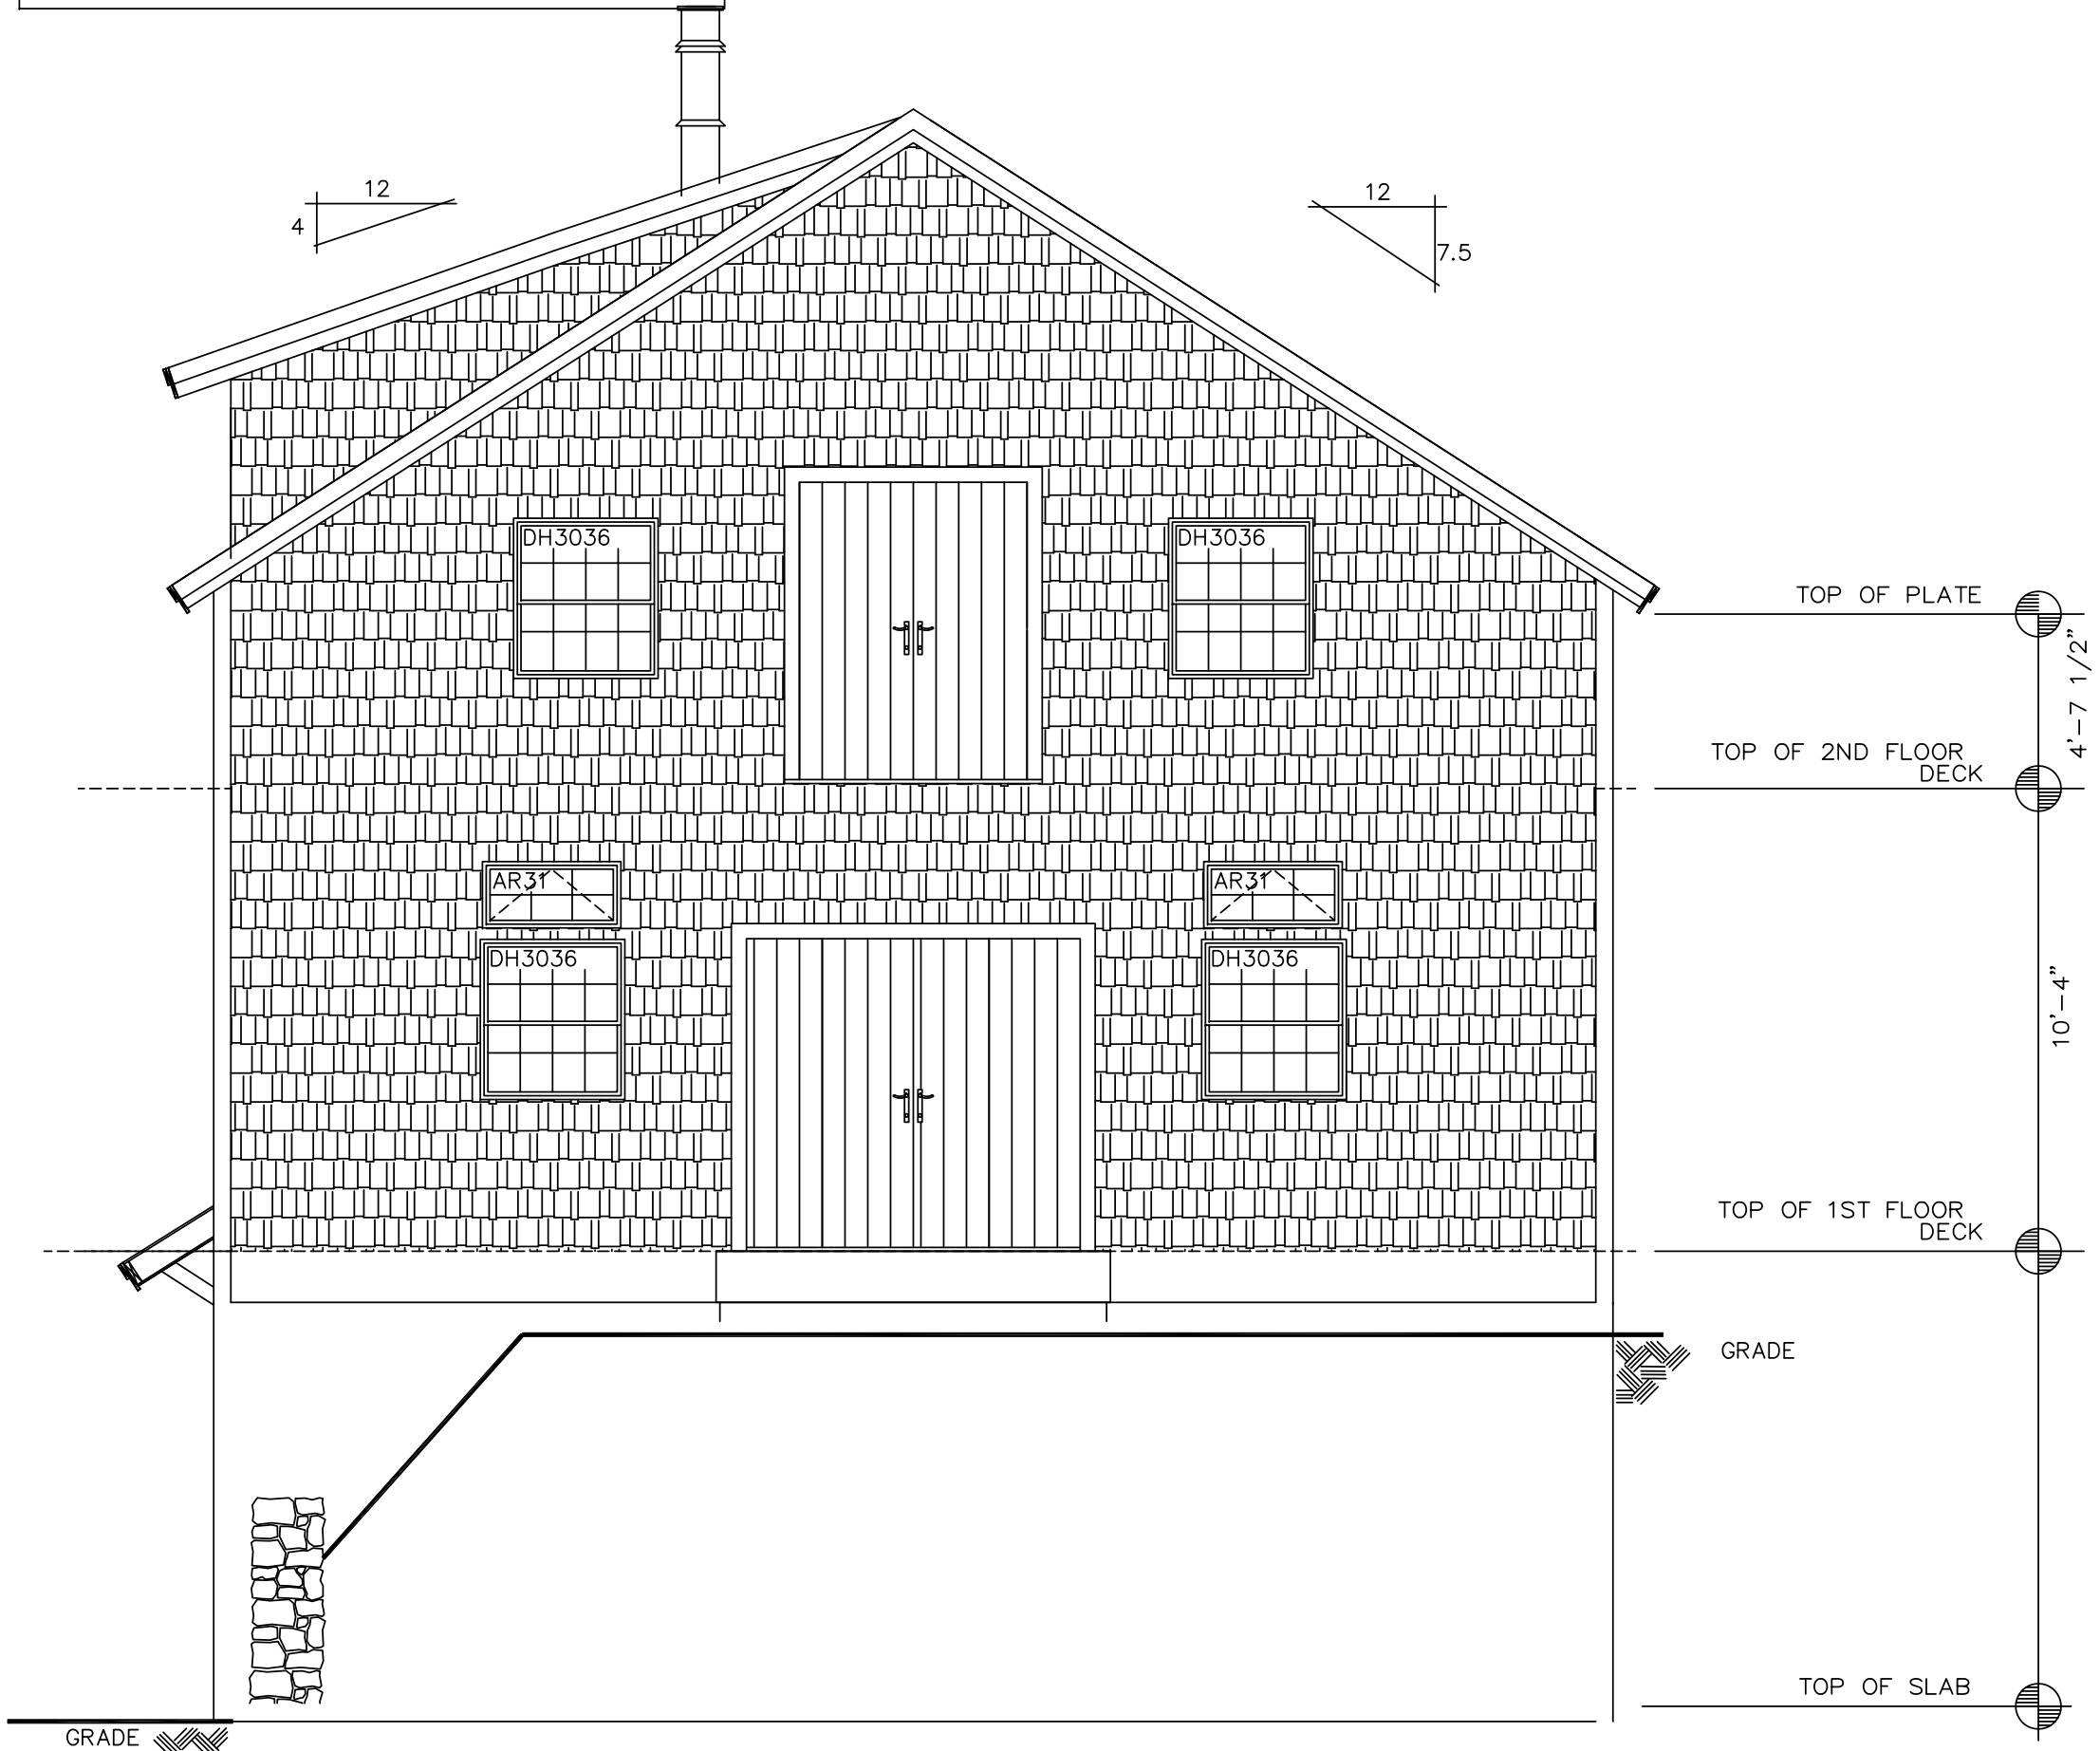

NORTH ELEVATION

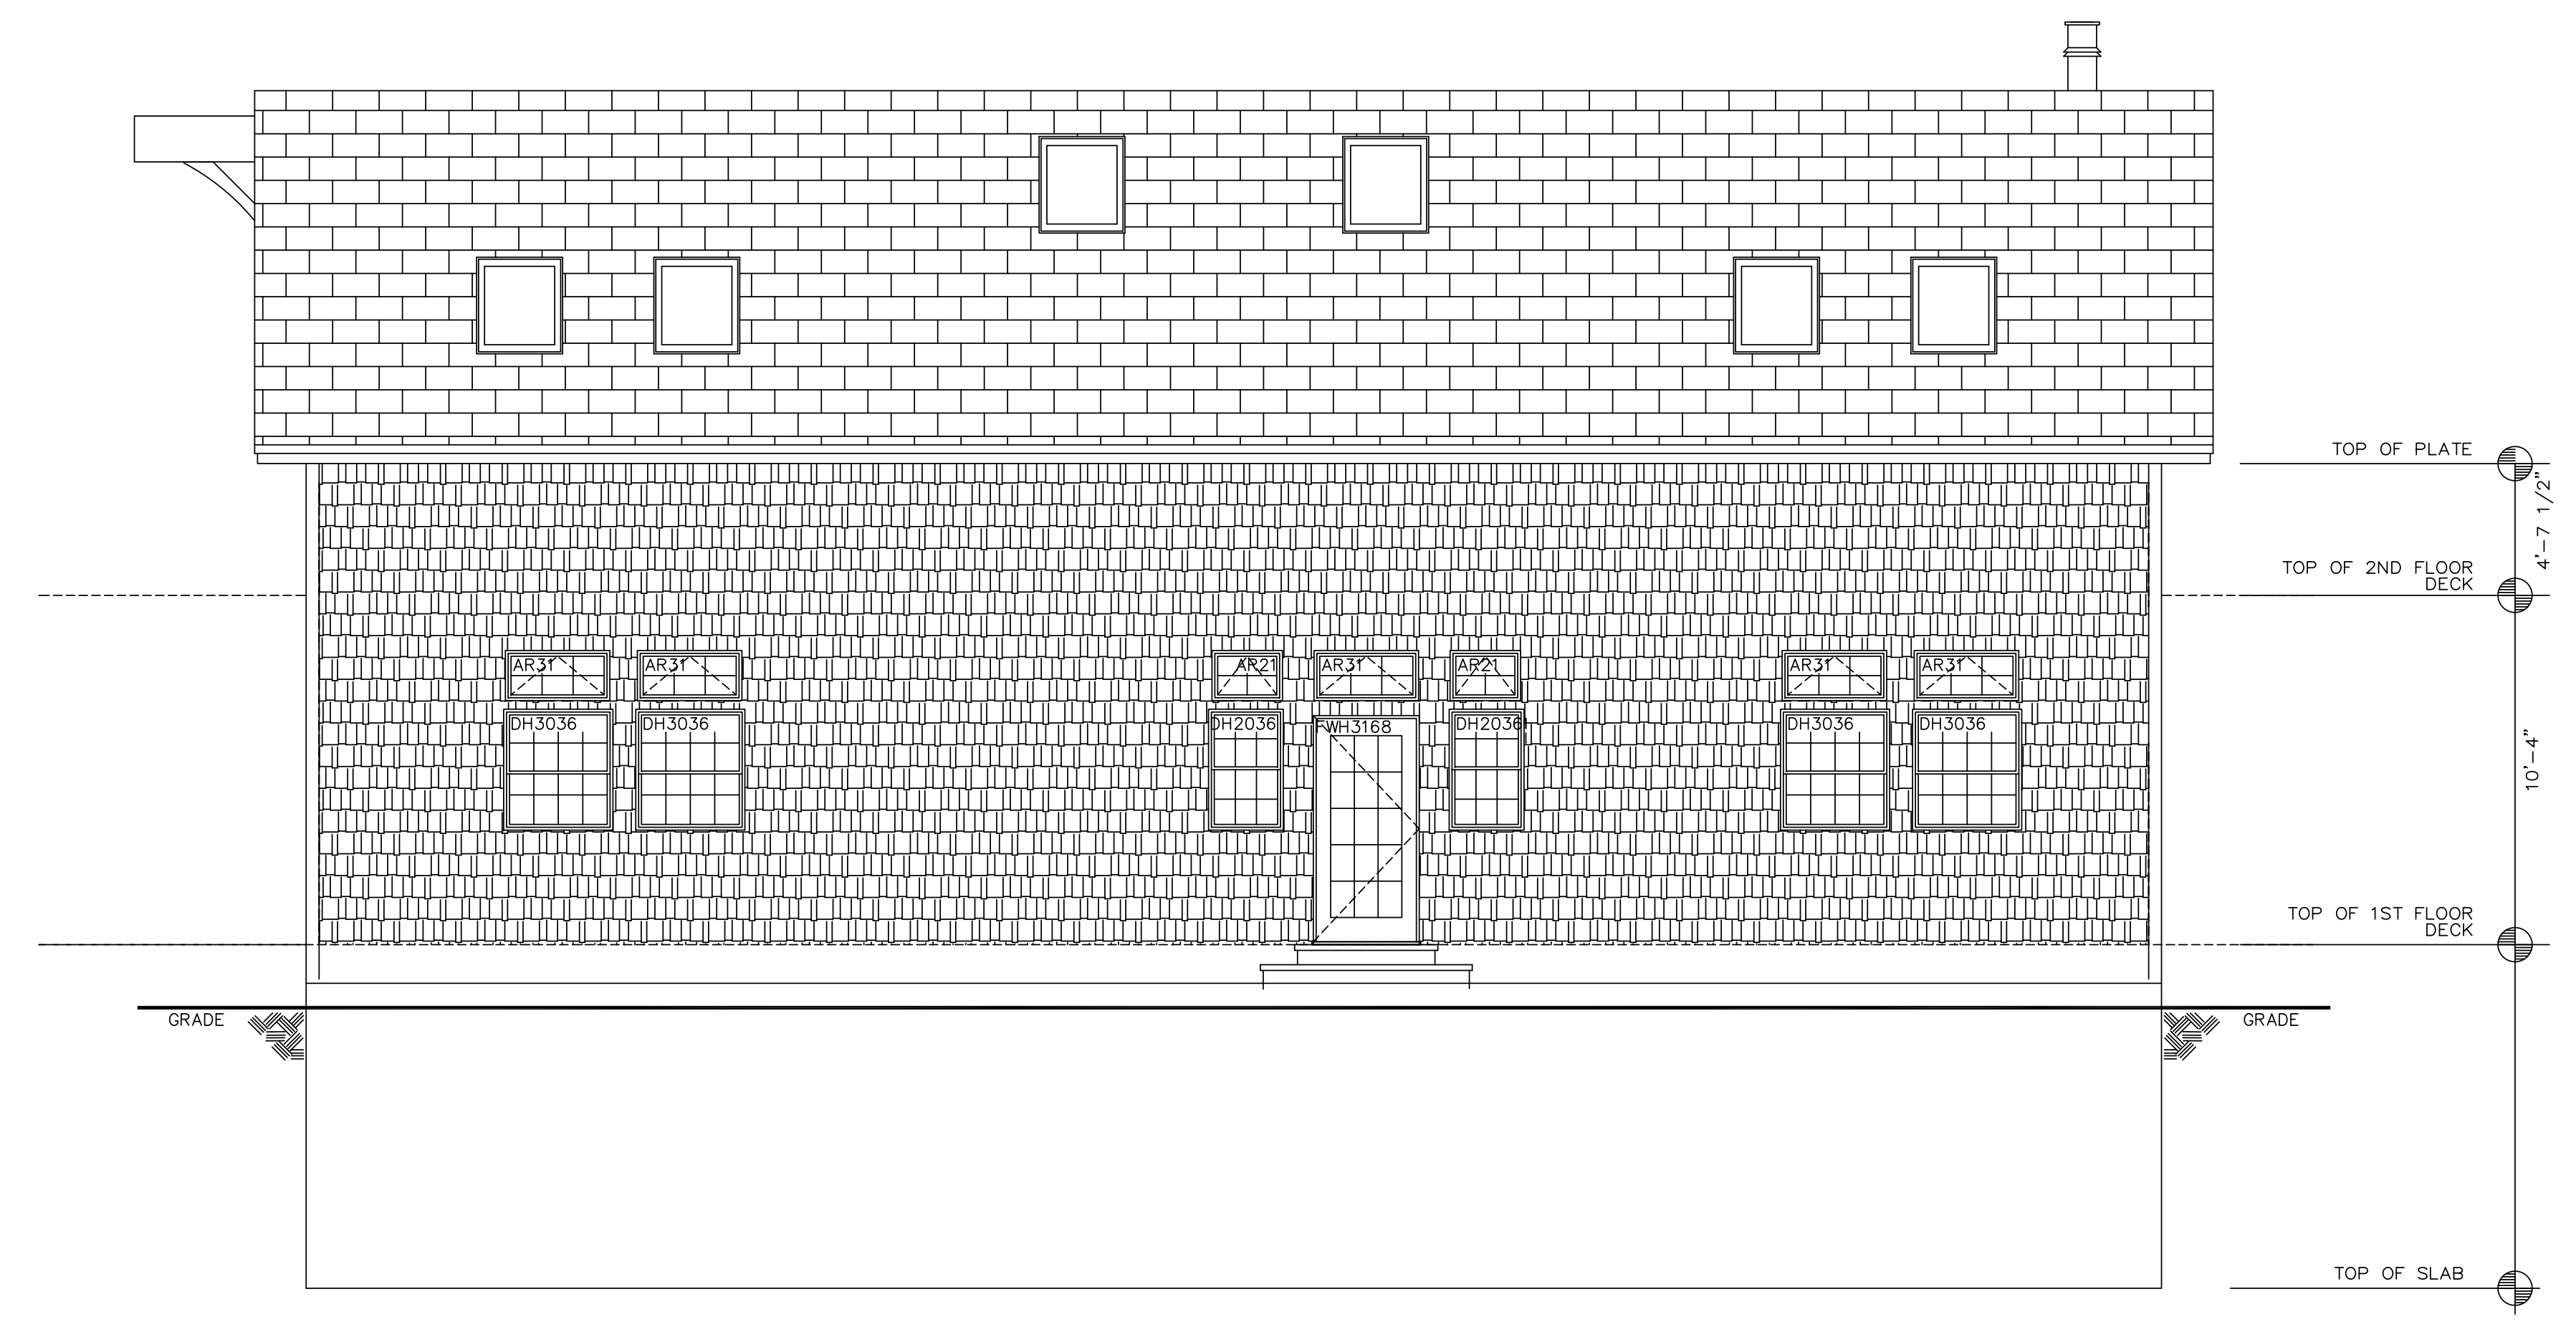

WEST ELEVATION

FRAME SPECIES IS EASTERN WHITE PINE #2 OR SELECT DOUGLAS FIR, #1 DOUGLAS FIR

ROOF: IS 6 1/2" STRUCTURAL INSULATED (UCC) PANELS. THEY SHALL BE APPLIED TO TIMBER FRAME OVER 3/4" T & G BOARDS.

WALLS: ARE 4 1/2" STRUCTURAL INSULATED (UCC) PANELS. THEY SHALL BE APPLIED TO TIMBER FRAME OVER 1/2" SHEETROCK.

REVISIONS	
DATE:	NUMBER & DESCRIPTION
5/11/03	
8/3/03	
11/5/03	
11/24/03	
2/3/04	

SCALE: 1/4" = 1'-0"

DATE: _____

DRAWN BY: **DEW**

CHECKED BY: _____

JOB NAME: **BRIAN BOYLE TRURO, MA**

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